



SIGN AREA = 45 SQ. FT.

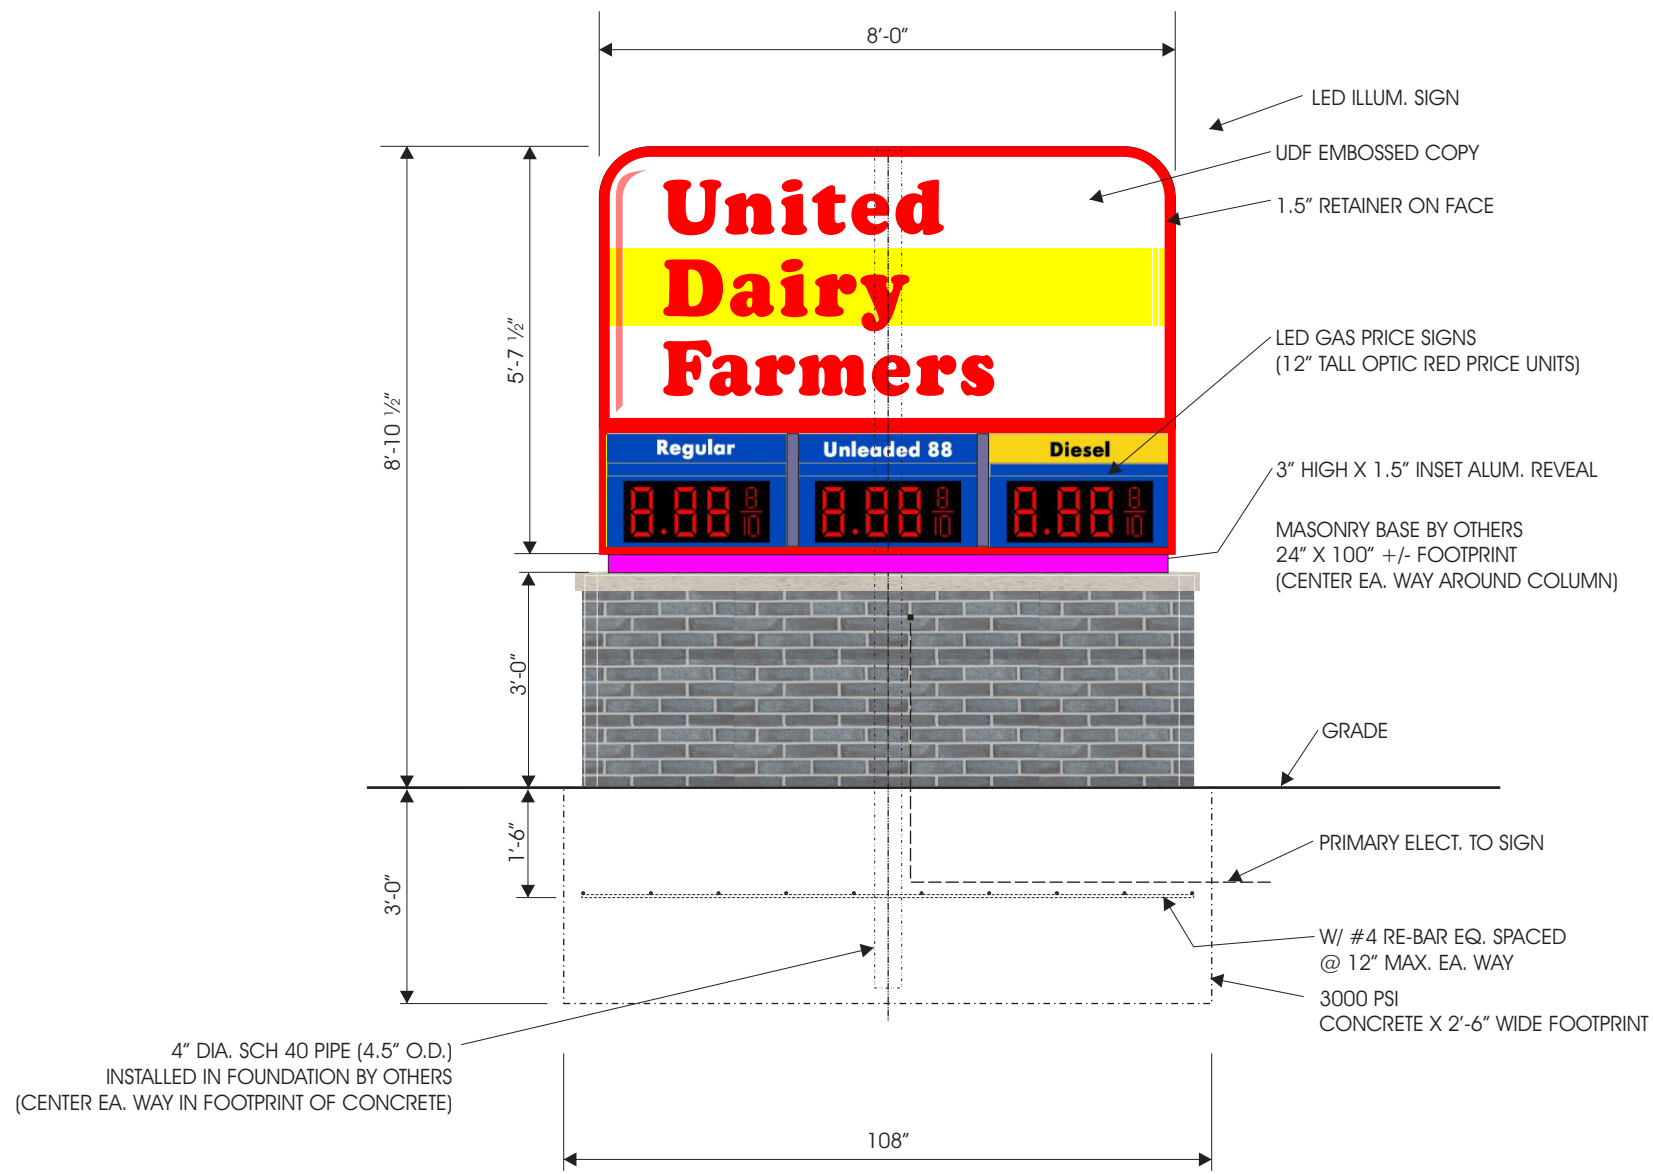

**ELEVATION**  
SCALE: 3/8" = 1'-0"

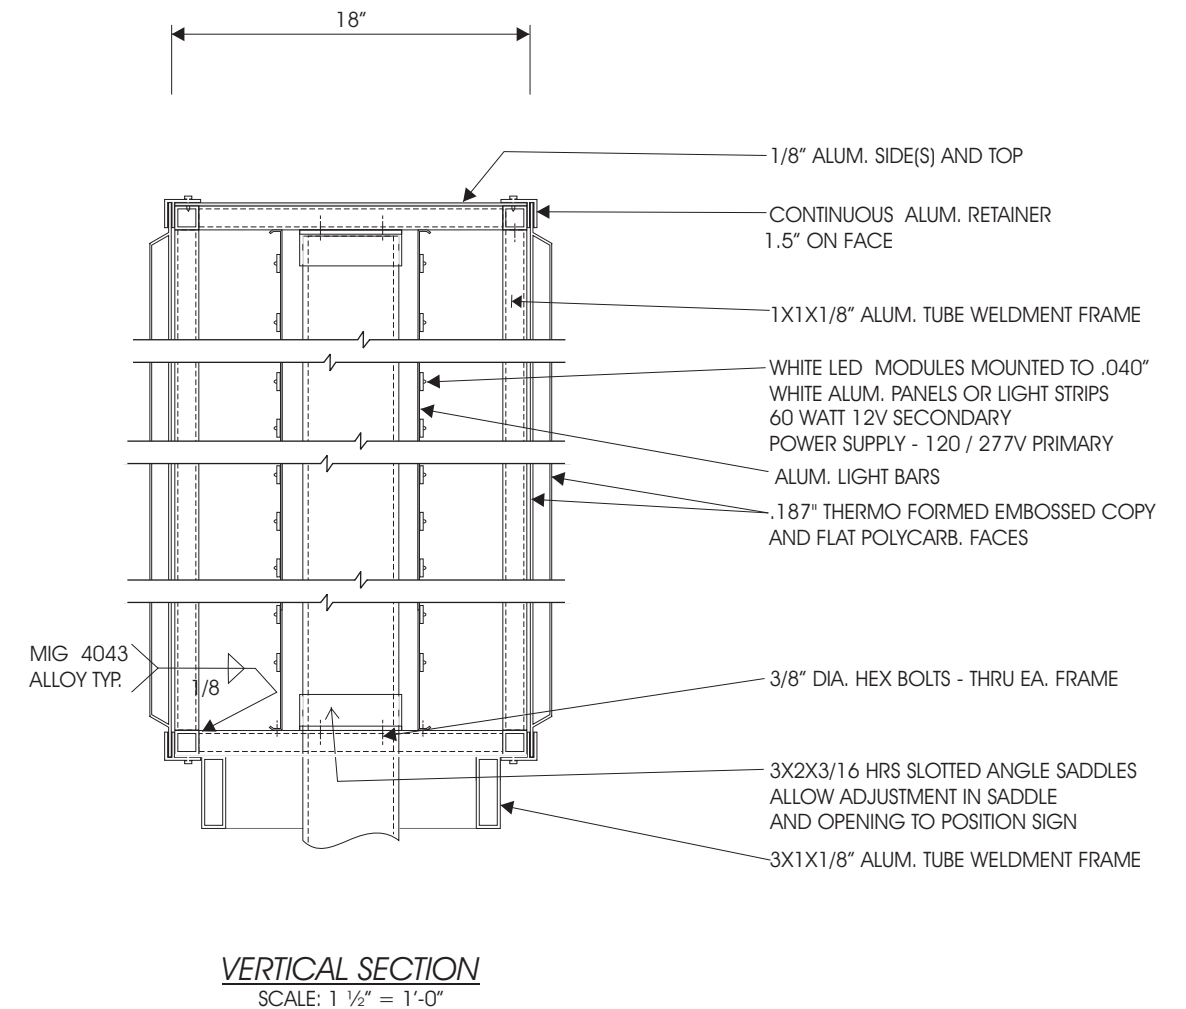

**VERTICAL SECTION**  
SCALE: 1 1/2" = 1'-0"

**SPECIFICATIONS**

- 1) ALL PIPE SHALL BE ASTM A53, GRADE B, Fy = 35 KSI
- 2) ALL STEEL ANGLES AND PLATES SHALL BE ASTM A36, Fy = 36 KSI
- 3) ALL BOLTS SHALL BE ASTM A307 OR SAE J429, GALVANIZED.
- 4) ALL STEEL WELDS SHALL BE MADE WITH E70XX ELECTRODES
- 5) ALUMINUM EXTRUSIONS SHALL BE 6061-T6 ALLOY
- 6) ALUM SHEET TO BE 5052 ALLOY
- 7) CONCRETE SHALL HAVE f'c = 3000 PSI
- 8) ALUM WELDS ALLOY 4043 FILLER
- 9) ALL EXPOSED SURFACES TO BE PRIMED & FINISHED WITH MATTHEWS ACRYLIC POLYURETHANE
- 10) ACRYLIC & POLYCARB. SHALL CONFORM TO ASTM D635 SPECIFICATIONS
- 11) SIGN TO BE U.L. AND HAVE SEAL AFFIXED TO THE UNIT
- 12) ELECTRIC WIRING AND DEVICES SHALL BE INSTALLED IN ACCORDANCE WITH 2017 OBC 3107.6, 2701.1 AND NFPA70

**DESIGN LOADS**

2017 OBC  
BASIC WIND SPEED (3 SECOND GUST) = 90 MPH  
WIND EXPOSURE C  
DESIGN WIND PRESSURE = 25.3 PSF  
WIND LOADS CONTROL DESIGN OVER SEISMIC LOADS




SCALE: NOTED	APPROVED BY:	DRAWN BY: Rct
DATE: 7-11-22		REVISED:
<b>PROPOSED GROUND SIGN</b>		
UNITED DAIRY FARMERS BEECHMONT AND ELSTON		DRAWING NUMBER 0371-1

COLOR NOTE: THE LETTERS ARE TO HAVE  
BLACK RETURNS WITH BLACK  
TRIM CAP

UDF STOREFRONT ENTRY WALL SIGN  
- INDIVIDUAL LETTERS  
- SIGN AREA = 55 SQ. FT.  
(2) REQ'D.

1'-10"

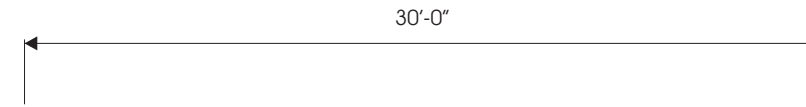


**United Dairy Farmers**

PROPOSED SIGN ELEVATION  
SCALE: 3/16" = 1'-0"

PROPOSED SIGN



PROPOSED STOREFRONT ELEVATION  
SCALE: NTS

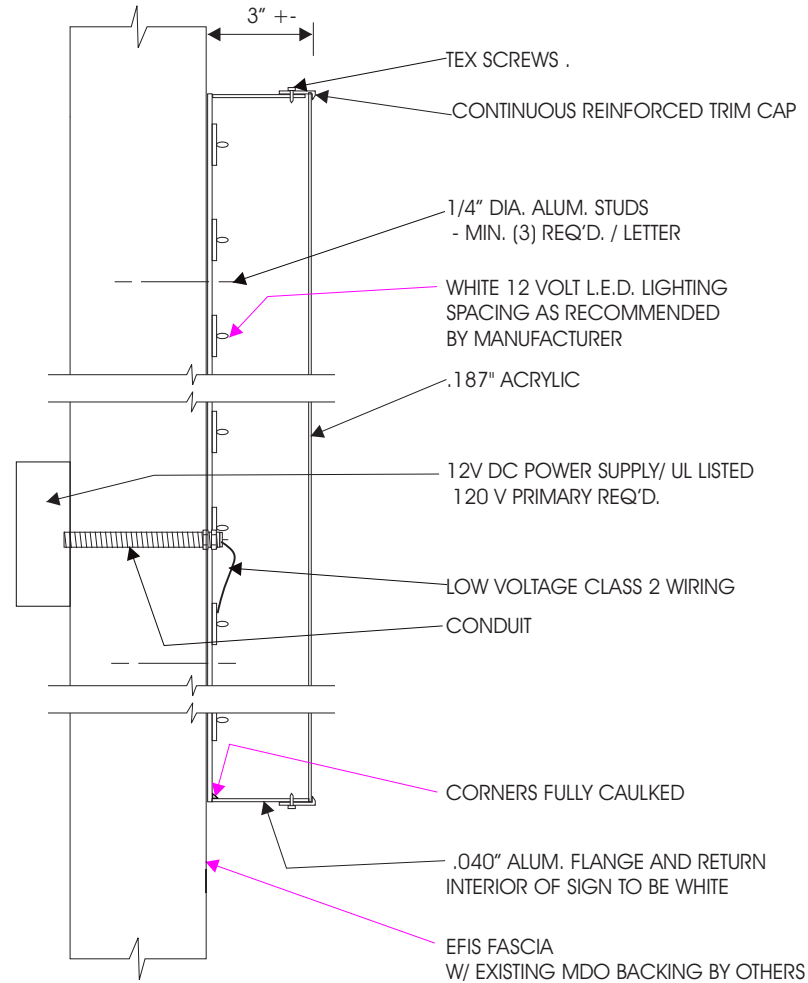

VERTICAL SECTION (THRU LETTERS)  
SCALE: 1 1/2" = 1'-0"

SPECIFICATIONS

- 1) SIGN TO BE U.L. AND HAVE SEAL AFFIXED TO THE UNIT
- 2) ELECTRIC WIRING AND DEVICES SHALL BE INSTALLED IN ACCORDANCE WITH 2024 OBC 3107, 2701.1 AND 2023 NEC, NFPA 70  
SIGNS WILL HAVE DISCONNECTING MEANS PER 2023 NEC ARTICLE 600.6
- 3) SIGN SHALL BEAR THE MANUFACTURER'S MARKINGS ( HLS )  
AND SHALL BE MAINTAINED BY HLS
- 4) ACRYLIC. SHALL CONFORM TO ASTM D635 SPECIFICATIONS
- 5) PROPOSED MAXIMUM SIGN LTR. WT. = <5#
- 6) ALL EXPOSED METAL NON-PLATED SURFACES TO  
BE FINISHED W/ CATALYZED ACRYLIC POLYURETHANE PAINT.
- 7) GRAPHIC LAYOUT & COLORS PER CUSTOMER SPEC'S.
- 8) ALUM. TO BE ALLOY 5052
- 9) ALUM. SHEET TO BE ALLOY 5052
- 10) BOLTS TO CONFORM TO ASTM A193 GRADE B OR EQ.


DESIGN LOADS

2024 OHIO BUILDING CODE  
BASIC WIND SPEED (3 SECOND GUST) = 115 MPH  
WIND EXPOSURE 'C'  
DESIGN WIND PRESSURE = 25.3 PSF  
WIND LOADS CONTROL DESIGN OVER SEISMIC LOADS




SCALE: NOTED	APPROVED BY:	DRAWN BY: Rct
DATE: 10-24-24		REVISED:
<b>PROPOSED WALL SIGN</b> (ON STOREFRONT ELEVATION)		
UNITED DAIRY FARMERS BEECHMONT AVE.		DRAWING NUMBER 0371-2


COLOR NOTE: THE LETTERS AND STRIPE ARE TO HAVE BLACK RETURNS WITH BLACK TRIM CAP

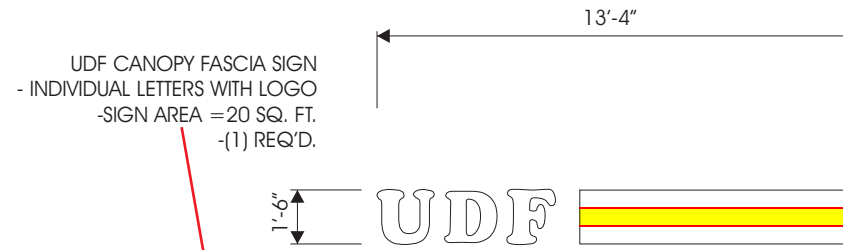

**PROPOSED SIGN ELEVATION**  
SCALE: 3/16" = 1'-0"

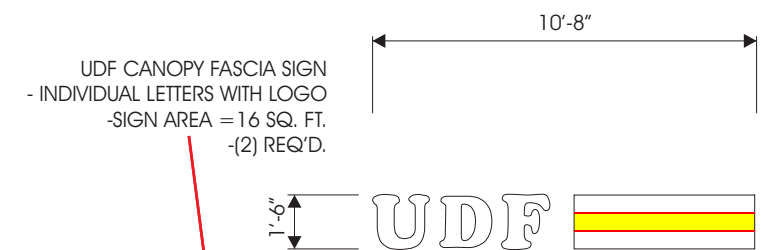

**PROPOSED SIGN ELEVATION**  
SCALE: 3/16" = 1'-0"

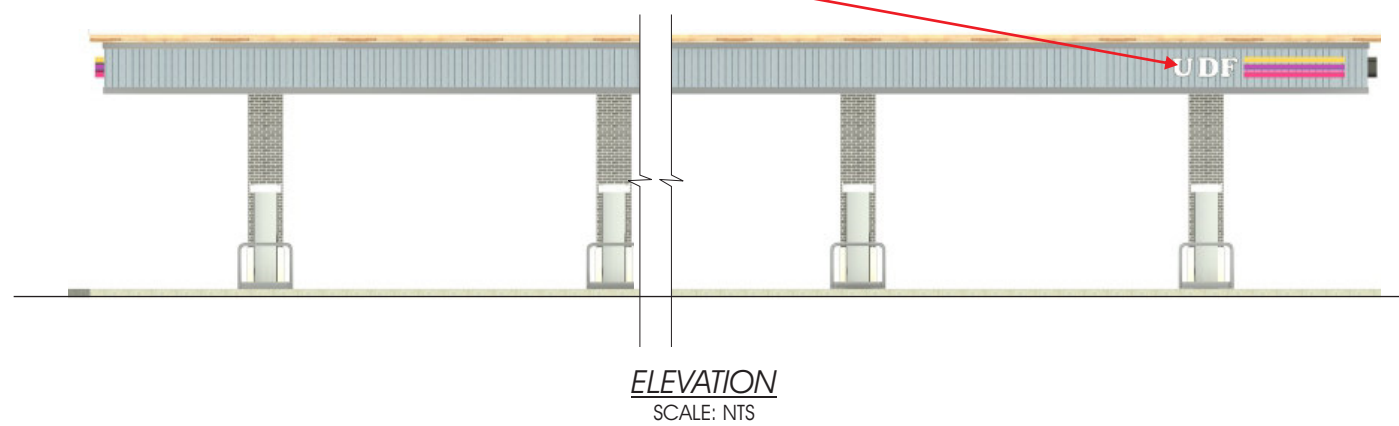


**ELEVATION**  
SCALE: NTS



**ELEVATION**  
SCALE: NTS



**ELEVATION**  
SCALE: NTS

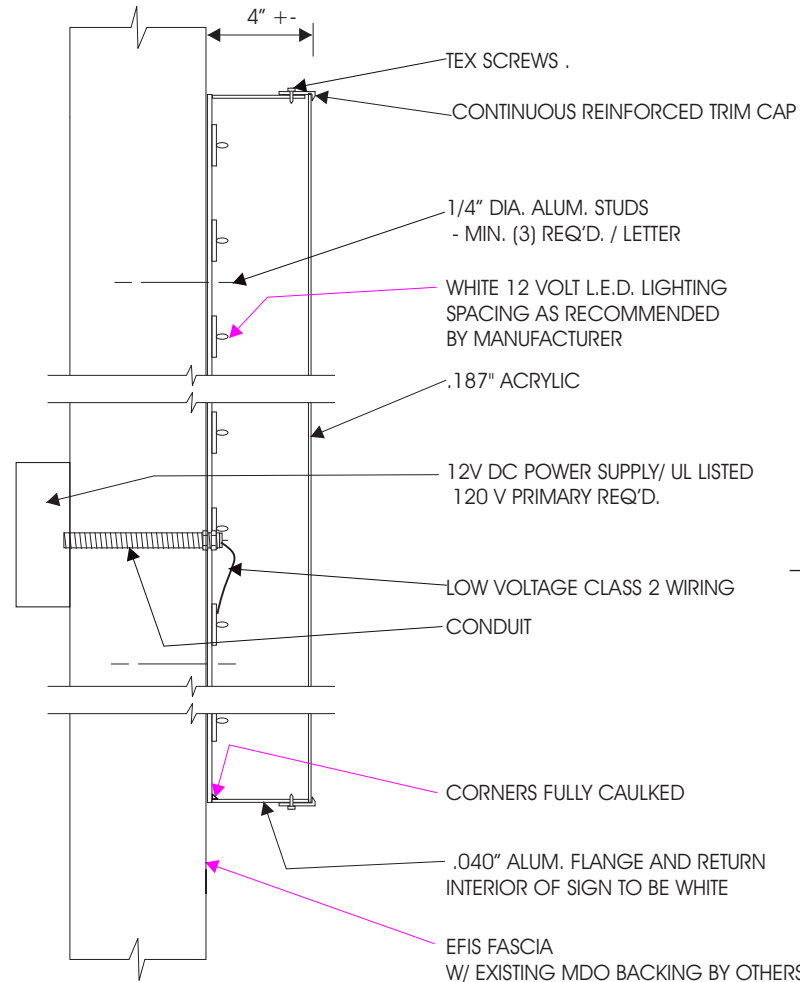

**VERTICAL SECTION** (THRU LETTERS)  
SCALE: 1 1/2" = 1'-0"

**SPECIFICATIONS**


- 1) SIGN TO BE U.L. AND HAVE SEAL AFFIXED TO THE UNIT
- 2) ELECTRIC WIRING AND DEVICES SHALL BE INSTALLED IN ACCORDANCE WITH 2024 OBC 3107, 2701.1 AND 2023 NEC, NFPA 70 SIGNS WILL HAVE DISCONNECTING MEANS PER 2023 NEC ARTICLE 600.6
- 3) SIGN SHALL BEAR THE MANUFACTURER'S MARKINGS ( HLS) AND SHALL BE MAINTAINED BY HLS
- 4) ACRYLIC. SHALL CONFORM TO ASTM D635 SPECIFICATIONS
- 5) PROPOSED MAXIMUM SIGN LTR. WT. = <5#
- 6) ALL EXPOSED METAL NON-PLATED SURFACES TO BE FINISHED W/ CATALYZED ACRYLIC POLYURETHANE PAINT.
- 7) GRAPHIC LAYOUT & COLORS PER CUSTOMER SPEC'S.
- 8) ALUM. TO BE ALLOY 5052
- 9) ALUM. SHEET TO BE ALLOY 5052
- 10) BOLTS TO CONFORM TO ASTM A193 GRADE B OR EQ.

**DESIGN LOADS**


2024 OHIO BUILDING CODE  
BASIC WIND SPEED (3 SECOND GUST) = 115 MPH  
WIND EXPOSURE 'C'  
DESIGN WIND PRESSURE = 25.3 PSF  
WIND LOADS CONTROL DESIGN OVER SEISMIC LOADS




SCALE: NOTED		APPROVED BY:		DRAWN BY: Rct	
DATE: 10-24-24				REVISED:	
<b>PROPOSED WALL SIGNS</b> (ON GAS CANOPY ELEVATIONS)					
UNITED DAIRY FARMERS BEECHMONT AVE.				DRAWING NUMBER 0371-3	

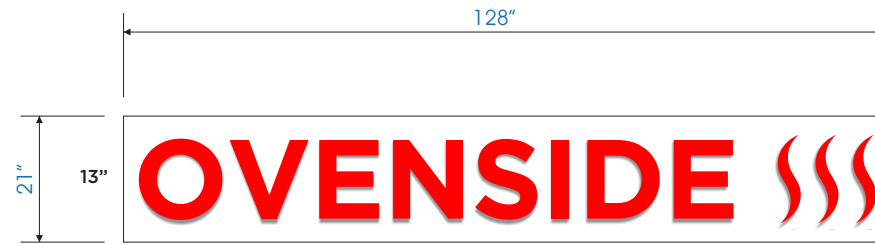

**SIGN ELEVATION**  
SCALE: 3/8" = 1'-0"  
SIGN AREA = 19 SQ. FT.

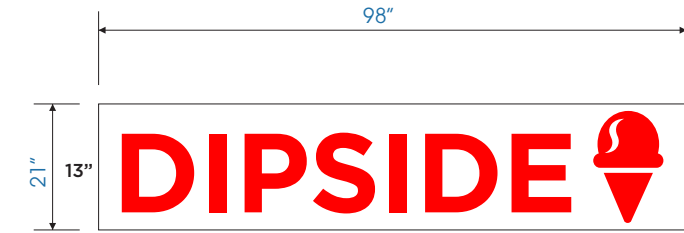

**SIGN ELEVATION**  
SCALE: 3/8" = 1'-0"  
SIGN AREA = 15 SQ. FT.

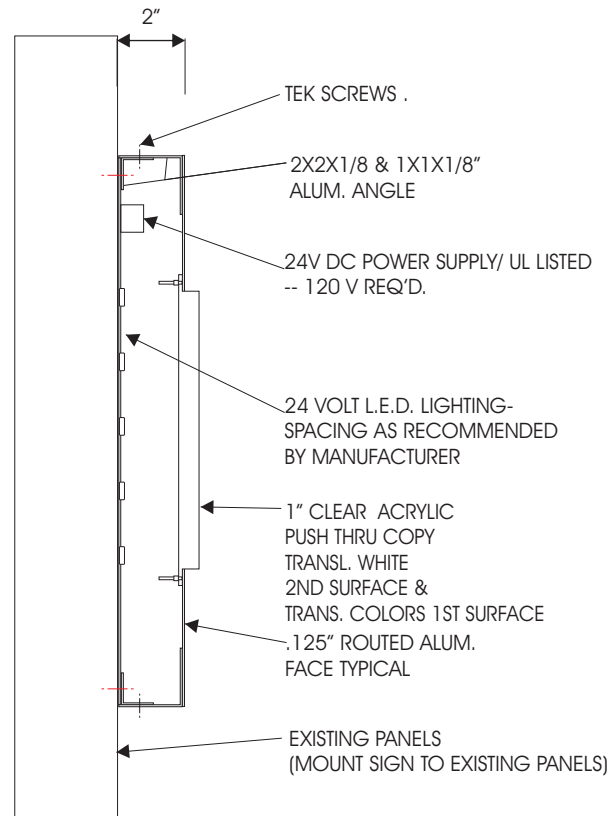

**SECTION THROUGH SIGN**  
SCALE: NTS



**ELEVATION**  
SCALE: NTS

**SPECIFICATIONS**

- 1) ALL SIGNS TO BE U.L. AND HAVE SEAL AFFIXED TO THE UNIT
- 2) ELECTRIC WIRING AND DEVICES SHALL BE INSTALLED IN ACCORDANCE WITH 2024 OBC 3107.6, 2701.1 AND NFPA70
- 3) ALL SIGNS SHALL BEAR THE MANUFACTURER'S MARKINGS ( HLS ) AND SHALL BE MAINTAINED BY HLS
- 4) ACRYLIC FACES SHALL CONFORM TO ASTM D635 SPECIFICATIONS
- 5) PROPOSED ESTIMATED SIGN WT. = <100#
- 6) ALL EXPOSED METAL NON-PLATED SURFACES TO BE FINISHED W/ CATALYZED ACRYLIC POLYURETHANE ENAMEL PAINT.
- 7) GRAPHIC LAYOUT & COLORS PER CUSTOMER SPEC'S.
- 8) ALL BOLTS SHALL BE CONFORM TO ASTM A307 OR SAE J429
- 9) UPON INITIAL LAYOUT, PROPOSED SIGN WILL REQUIRE (1) 20 AMP 120V CIRCUIT. ELECTRICAL REQUIREMENTS TO BE RE- EVALUATED UPON FINAL APPROVAL OF GRAPHICS LAYOUT.

**DESIGN LOADS**

2024 OBC  
BASIC WIND SPEED (3 SECOND GUST) = 115 MPH  
WIND EXPOSURE C  
DESIGN WIND PRESSURE = 25.3 PSF  
WIND LOADS CONTROL DESIGN OVER SEISMIC LOADS



SCALE: NOTED	APPROVED BY:	DRAWN BY: Rct
DATE: 10-24-24		REVISED:
<b>PROPOSED WALL SIGNS</b> (ON EXISTING TRELLIS)		
UNITED DAIRY FARMERS BEECHMONT AVE.		DRAWING NUMBER 0371-4